## **CONSTRUCT**

Construct Design & Building Group 13/35 Birch Street, Condell Park, NSW 2200. Email: info@constructau.com.au

61 Batt Street, Sefton

SECONDARY DWELLING AND SWIMMING POOL Project no. 24-001

Issued for DA





LOT SIZE: 575.4m<sup>2</sup>

COUNCIL COMPLIANCE	ALLOWED	PROVIDED	COMPLY
MIN FRONTAGE	12	37	YES
MAX SITE COVERAGE	N/A	N/A	N/A
FLOOR SPACE RATIO	0.5:1	0.3:1	YES
MAX BUILDING HEIGHT	4.5m	4.3m	YES
FRONT SETBACK	GF= 5.5M	GF= 37m	N/A
SIDE SETBACK 1	0.9m	0.9m	YES
SIDE SETBACK 2	0.9m	0.9m	YES
REAR SETBACK	0.9m	0.9m	YES
CORNER SETBACK	N/A	N/A	N/A
LANDSCAPE AREA	min 20% of site area	20%	YES
PRIVATE OPEN SPACE	80m²	105m²	YES



### SITE CALCULATION

EXISTING DWELLING	110m²
PROPOSED GARAGE	N/A
PROPOSED GRANNY FLAT	60m²

### SHEET SCHEDULE

Cover Page
Title Page
Building Specification
Basix Comments
Site Plan/Analysis Proposed
Demolition Plan
Site Plan/Analysis Existing
Ground Floor Plan Proposed
Ground Floor Plan Exisiting
Sections Proposed
Elevations
Elevations
Elevations Proposed
Shadow Diagrams - June
Shadow Diagrams - June
Concept Landscap Plan
Neighbour Notification

## STANDARD SPECIFICATION

#### BE ADVISED: SOME CLAUSES IN THIS SPECIFICATION MAY NOT BE RELEVANT TO THIS PROJECT

#### 1.0 GENERAL

- 1.1 ALL DIMENSIONS SHALL BE CHECKED ON SITE PRIOR TO COMMENCEMENT ANY WORK.
- 1.2 ALL MATERIALS SHALL COMPLY WITH RELEVENT CURRENT AUSTRLIAN
- STANDARDS AND SHALL BE NEW AND THE BEST OF THEIR RESPECTIVE KINDS AND SUITABLE FOR THEIR INTENDED PURPOSES.
- ALL WORKMANSHIP SHALL COMPLY WITH RELEVENT CURRENT AUSTRALIAN
- STANDARDS AND TO GOOD TRADE PRACTICES.
- 1.4 ALL WORK SHALL BE IN ACCORDANCE WITH REQUIREMENTS OF THE
- RESPECTIVE AUTHORITY HAVING JURISDICTION OVER THE WORKS. 1.5 THE ARCHITECTURAL DRAWINGS SHOULD BE READ IN CONJUNCTION WITH
- THE SPECIFICATION. SCHEDULES AND CONSULTANTS DRAWINGS THAT FORMS
- PART OF THE CONSTRUCTION DOCUMENTS REFERRED TO IN THE "BUILDING CONTRACT."
- DO NOT SCALE FROM DRAWINGS. NOTIFY OF ANY ERRORS OR OMISSIONS
- BEFORE PROCEEDING WITH ANY WORKS.
- 1.7 ENSURE THAT BACKGROUNDS ARE SUITABLE FOR THE INTENDED SUBSEQUENT FINISHES, COMMENCEMENT OF WORK ON THE BACKGROUNDS
  - IMPLIES ACCEPTANCE BY THE SUBCONTRACTOR OF THE BACKGROUNDS ON WHICH FINISHES
- 1.8 SUPPLY ALL EQUIPMENT NECESSARY FOR THE COMPLETION OF RESPECTIVE WORKS.
- PROGRESSIVELY CLEAN UP AFTER THE COMPLETION OF RESPECTIVE WORKS.

#### 2.0 EARTHWORKS

- 2.1 UNLESS OTHERWISE STATED, REMOVE TOPSOIL TO A MINIMUM DEPTH OF 200mm INCLUDING ALL ROOTS, AND OTHER MATTER, AND REQUIRED BY THE
  - SOIL CONDITION AND/OR THE BUILDER PROVIDE SUITABLE CLEAN FILLING
  - SAND AND COMPACT IN LAYERS NOT GREATER THAN 300mm TO REDUCE LEVELS AS SHOWN
- COMPACT SAND FILLING AND SANDY SUB GRADES UNDER FOOTINGS AND
- SLAB TO OBTAIN MIN. SEVEN (7) BLOWS PER 300mm ON A STANDARDS PERTH
- SAND PENEFROMETER TEST (AS PER AS 1289 F3.3) 2.3 DO NOT EXCAVATE SERVICES TRENCHES WITHIN AN ANGEL OF 45 DEGREES DOWN FROM BOTTOM EDGE
- 2.4 ALL RETAINING WALLS TO BE TREATED WITH "BITKOTE" WATERPROOFING AGENT.

#### 3.0 CONCRETE

- ENGINEERS DETAILS, RELEVANT BUILDING CODES AND STANDARDS
- ALL CONCRETE TO CONFORM TO THE REQUIREMENTS OF AS 3600 CONCRETE STRENGTH GRADE: N20. AGGREGATE 20mm. SLUMP 80mm.
- SLAB IS TO BE CURED FOR 7 DAYS MIN. & SLAB REINFORCEMENT PLACED ON APPROVED CHAIRS TO
- THE FOOTING AND SLAB CONSTRUCTION IS TO COMPLY WITH AS 2870.
- PROVIDE A PROPRIETARY VAPOR BARRIER WHICH CONSISTS OF HIGH IMPACT
  - RESISTANT POLYTHENE FILM MIN. 0.2mm THICK WHICH HAS BEEN PIGMENTED AND BRANDED BY
- - PROVIDE ANTI-TERMITE TREATMENT UNDER THE BUILDING AREAS IN

  - BUILDER SHALL PROVIDE "DURSRAN" (HAND SPRAYED ORGANO-PHOSPHATE)
  - OR SIMILAR APPROVED ANTI-TERMITE TREATMENT IN ACCORDANCE WITH REELEVANT AUSTRALIAN STANDARD CODES.

#### 4.0 BRICKWORK

- - AS A123 MASONRY CODE
  - MORTAR FOR MASONRY CONSRUCTION
- BRICK GALIGE 7 STANDARD COLIRSES = 600mm
- ALL BRICKS SHOULD HAVE MIN. COMPRESSIVE STRENGTH OF 20MP
  - AND AS FOLLOWS:
  - EXTERNAL FACE WORK: 230x110x76mm
  - EXTERNAL RENDER: 305x162x90mm MAXIBRICK OR VERTICORE
  - 2c FACE BRICK SPLAYED SILLS SOLID FACEBRICK COURSE
  - WITH BED JOINT AND PERPENDS FILLED
    - 305x76x90mm LONGREACH OR IUMBO FOR
- COURSE ADJUSTMENT MORTAR: 1:1:6 CEMENT:LIME:SAND
- - EVERY 5TH COURSE AT APPROXIMATELY 900mm CENTRES, WITH ADDITIONAL TIES AT THE RATE OF 1 TIE/300mm HEIGHT OF OPENINGS AND VERTICAL
  - CONTROL JOINTS AND WITHIN 150mm OF THE OPENINGS. BUILD TIES INTO
  - EACH LEAF AT LEAST 50mm. VERTICAL CONTROL JOINTS SHALL BE 12mm WIDE

- KEEP CAVITIES CLEAR OF MORTAR. PROVIDE CAVITY BOARDS. TEMPORARILY OMIT BRICKS TO PERMIT RAKING OUT OF CAVITY BOTTOMS.
- - FILL. KEEP CLEAR OF MORTAR. DO NOT LOCATE WEEPHOLES CLOSER THAN 500mm TO JOINTS IN DAMP PROOF COURSES OR FLASHINGS.
- PROVIDE DAMP PROOF COLIRSES (DPC) IN THE BOTTOM 3 COLIRSES OF BRICK WORK AND SLAB AND/OR FOOTINGS. DPC ADDITIVE SHALL BE CLEAR IN
- SETOUT BRICKWORK ACCURATELY, PLUMB, LEVEL AND PROPERLY BONDED
  - RISING WORK TO BE RAKED BACK, JAMBS, REVEALS, CORNERS, PERPENDS. FTC TO BE TRUE PILIMB AND IN LINE WITH PERPENDS TRUE TO LINE
  - SETOUT DOOR FRAMES NEAR PERPANDICULAR WALL WITH A MARGIN OF
- MOISTEN ALL EXTRUDED BRICKS BEFORE LAYING.
- PROVIDED 12mm PLASTERING MARGIN BETWEEN WINDOW FRAME AND
- INTERNAL BRICKWORK TO BE PLASTERED.
- WHERE NECESSARY REINFORCE BELOW AND OVER OPENINGS WITH GALVANISED WOVEN WIRE FABRIC 75mm WIDE IN CENTRE OF EACH LEAF LOCATED IN 2 COUSES BELOW SILL AND IN THE 2 COURSES ABOVE AN OPENING EXTENDING A MINIMUM OF 600mm BEYOND THE OPENING.
- 4.13 BUILD IN ALCOR/PGLELASHINGS AS FOLLOWS:
  - -WHEREVER SHOWN ON DRAWINGS.

  - -OVER LINTELS TO EXPOSED OPENINGS:
    - FULL WIDTH OF OUTER LEAF CONTINUOUS ACROSS CAVITY 50mm INTO
  - INNER LEAF 2c ABOVE.
    - FULL WIDTH OF EXTERAL LEAF, STEPPED TO ROOF SLOPE TURNED DOWN MIN
    - 50mm OVER BASE FLASHING. TURN UP IN CAVITY SLOPING INWARDS AND BUILT

FULL HIGHT 150mm WIDE FIXED TO FRAMES INTERLEAVED WITH SILL AND HEAD

- INTO INNER LEAF 1c ABOVE. -DOOR / WINDOW STILES:
- -STRUCTURE OR SERVICES WITHIN 30mm OF OUTER BRICK LEAF IN CAVITY-
- VERTICAL FLASHINGS CONTINUOUS 1c BELOW FL TO ABOVE STRUCTURE OR FRAME. NOMINAL 300mm WIDE. FOR HORIZONTAL STRUCTURES / SERVICES:
- CONTINUOUS FLASHING BUILT IN AS FOR OVER LINTELS. -AT CAVITY WALLS WITH GLASS BLOCK 300mm WIDE FIXED TO GLASS BLOCK FRAME
- AND TURNED AWAY IN CAVITY FROM INNER LEAVE

#### 4.14 LINTELS

MAX SPAN	LINTELS SIZE	BEARING	
(mm)	(VERT x HORIZ x THICK)	EACH END (mm)	
900	75x10	150	
1200	75x75x8	150	
1500	90x90x8	150	
1800	100x75x8	230	
2100	125x75x8	230	
2400	125x75x10	230	
2500	100x100x8	230	
3000	150x90x10	230	

#### 5.0 CARPENTRY WORK

- ROOF AND CEILING FRAMING SHOULD COMPLY WITH AS 1684 LIGHT TIMBER FRAMING CODE, DRAW STRAP FIRMLY OVER WALL PLATES AND SECURELY FIX TO TOP OF PLATE
- REFER TO AS 1684 FOR ROOF FRAMING SIZES LINLESS SPECIFIED ON DRAWINGS
- SUPPLY AND FIX ALL BULKHEADS & FALSE CEILINGS AS SHOWN ON THE DRAWINGS

#### 6.0 METALWORK

- ELECTRIC AND GAS METER BOXES AS SHOWN IN DRAWINGS
- WINDOW FRAMES SHALL BE RESIDENTIAL OR COMMERCIAL SECTION WITH POWDERCOAT FINISH AS SELECTED BY OWNER, ALLOW FOR FLYSCREENS TO ALL WINDOWS, REFER TO ADDENDUM, ANGLED WINDOW UNITS SHALL BE FACTORY MADE
- AND FIXED AND DELIVERED ON SITE AS COMPLETE UNIT. CLOTHES HOIST: REFER TO ADDENDUM

#### 7.0 ROOFING

- 7.1 SELECTED ROOFING MATERIAL SHALL BE INSTALLED AND FIXED IN ACCORDANCE WITH MANUFACTURERS SPECIFICATION AND RELEVANT BUILDING CODES
- 7.2 GUTTER, FASCIA, DOWN PIPES, FLASHINGS SHALL BE IN LONGEST POSSIBLE LENGTHS AND SHALL MATCH EXISTING.

7.3 DOWN PIPES SHALL MATCH EXISTING.

GUTTERS: AROUND ROOF PENETRATIONS ETC.

- 7.4 ALLOW FOR ALL JOINTS AND JOINING MATERIALS, COLLARS, STRAPS & FASTENINGS NECESSARY TO COMPLETE WORK.
- 7.5 ALLOW FOR ALL ROOF PENETRATIONS, ROOF COWLS, FLASHINGS, FLUMES THROUGH
- 7.6 FIX GUTTERS & FLASHINGS TO PERMIT THERMAL MOVEMENT IN THEIR FULL LENGTH
- 7.7 SEAL BETWEEN OVERLAPPING FLASHINGS: FLASHINGS TURNED DOWN OVER BASE OR APRON FLASHINGS: FLASHINGS OVER METAL ROOF: FLASHINGS OVER SECRET

#### 8.0 JOINERY

- 8.2 EXTERNAL DOOR FRAMES SHALL BE: 110x40 DOUBLE REBATED FRAME WITH 130x40 WEATHERED THRESHOLD U.N.O.
- SUPPLY AND BUILD IN TIMBER DOOR FRAMES TO EXTERNAL LOCATIONS AS SHOWN ON ARCHITECTURAL DRAWINGS.

#### 9.0 CEILINGS

- 9.1 CEILINGS SHALL BE RECESSED EDGE, MINIMUM 8.0mm PLASTERGLASS OR GYPROCK.
- 9,2 FLUSH JOINTS, SCREW HEADS, AND OTHER BLEMISHES IN THE SHEETS USING APPROVED SYSTEMS TO PROVIDE FLUSH SMOOTH CONTINUOUS SURFACE
- 9.3 PROVIDE AND FIX ALL FLUSH STOP BEADS & CASING BEADS TO ALL CORNERS & EDGES
- PROVIDE ALL SELECTED MOLDINGS AND CORNICES TO ALL CEILINGS AS STATED IN

#### 10.0 PLASTERING

- INTERNAL WALL FINISHES INCLUDING CUPBOARD, BIN, & FRIDGE RECESSES, ETC. SHALL BE (OTHER THAN FACE FINISHES OR WHERE COVERED BY FEATURE MATERIALS) FLOAT AND SET IN HARDWALL PLASTER U.N.O.
- PLASTERED WALLS SHALL BE NOMINAL 12mm THICK CONSISTING OF 1:1:9,
- SUPPLY AND FIX EXTERNAL CORNER BEADS TO ALL EXTERNAL CORNERS.
- PROVIDE STOP BEADS WHERE PLASTER WORK ABUTS TIMBER FRAMES, OR FACEWORK EXTERNAL RENDER WHEN APPLICABLE SHALL BE 2 COAT SAND FINISH. (FOR PAINTING)
- NIBS IN INTERNAL CORNERS ADJACENT TO DOOR FRAMES GREATER THAN 40mm SHALL NOT BE FLUSHED UP WITH FRAMES.
- PROVIDE V-JOINTS IN RENDER & FINISHING PLASTER WHERE BRICK WORK ABUTS OR JOINS ONTO CONCRETE WORK.

#### 11.0 GLAZING

- CLEAR GLASS GENERALLY: OBSCURE GLASS TO BATHROOMS, REFER TO DRAWINGS.
- ALL TO THE RELEVANT AUSTRALIAN STANDARDS
- WHERE GLASS BLOCKS HAVE BEEN NOMINATED. THEY SHALL BE IN FRAMES AND INSTALLED TO MANUFACTURES SPECIFICATIONS

#### 12.0 FLOORING FINISHES

REFER TO DRAWINGS & FINISHES SCHEDULE.

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- CARPET FLOOR COVERINGS TO NOMINATED AREAS COMPLETE WITH SELECTED UNDERLAY SMOOTH EDGE, DIMINISHING STRIPS ETC, TO COMPLETE THE WORKS:
- PROVIDE TILED FLOOR FINISHES TO NOMINATED AREAS COMPLETE WITH ALL MATERIALS ANGLE TRIMS ETC TO COMPLETE THE WORKS:
- PROVIDE TIMBER FLOOR FINISHES TO NOMINATED AREAS COMPLETE WITH ALL MATERIALS, POLISHED TO HIGH STANDARD WITH PREMIUM QUALITY SEALER (2 COATS).

- WHERE NECESSARY SUPPLY & FIX SELECTED UNIT AND HOUSE NUMBERS TO EACH UNIT AND TO LETTERBOXES AS SCHEDULED.
- "SLIPERDRAFT" RESERVES THE RIGHT TO ERECT A RUILDERS SIGN ON THE PROPERTY FACING THE STREET FRONTAGE IN COMPLIANCE WITH AUTHORITY REQUIREMENTS.

#### 14.0 PAVING

- GENERALLY: WHEN PAVING IS INCLUDED IN THE BUILDING CONTRACT, THE FOLLOWING SHALL APPLY AS A MINIMUM STANDARD
- SUPPLY AND LAY ALL PAVING TO EXTERNAL AREAS AS SHOWN ON WORKING DRAWINGS. 14.3 CUT, FILL AND COMPACT SAND TO REQUIRED LEVELS. SCREED TO UNIFORM THINNESS
- ANDIEVELS PROVIDE BRICK EDGE-RETRAINING FOOTING EMBEDDED IN MORTAR BENEATH THE
- CONCRETE FOOTING ALONG PERIMETER OF DRIVEWAY AND BED EDGE BRICK IN MORTAR
- PROVIDE 100mm COMPACTED LIMESTONE BASE TO DRIVEWAY TOPPED WITH 50mm CLEAN SAND AND GRADE TO FALLS.
- PAVING PATTERN: REFER TO ADDENDUM
- BRICK PAVERS SHALL BE:
- TRAFFICABLE AREAS: MIN. 65mm SOLID CLAY OR CONCRETE PEDESTRIAN AREAS: MIN. 43mm SOLID CLAY OR CONCRETE

## BASIX® Certificate Building Sustainability Index www.basix.nsw.gov.au

#### Single Dwelling

Certificate number: 1750654S

This certificate confirms that the proposed development will meet the NSW government's requirements for sustainability, if it is built in accordance with the commitments set out below. Terms used in this certificate, or in the commitments, have the meaning given by the document entitled "BASIX Definitions" dated 100@2020 published by the Department. This document is available at www.basix.nsw.gov.au



Project summary		
Project name	Proposed Granny-577	
Street address	61 BATT Street SEFTON 2162	
Local Government Area	Canterbury-Bankstown Council	
Plan type and plan number	Deposited Plan DP14966	
Lot no.	15	
Section no.		
Project type	dwelling house (detached) - second	ary dwelling
No. of bedrooms	1	
Project score		
Water	<b>✓</b> 40	Target 40
Thermal Performance	✓ Pass	Target Pass
Energy	✓ 78	Target 68
Materials	<b>✓</b> 18	Target n/a


Certificate Prepared by	
Name / Company Name: Elam Eco Design	
ABN (if applicable): 13300972631	


BASIX Department of Planning, Housing and www.basix.nsw.gov.au Version: 4.03 / EUCALYPTUS\_03\_01\_0 Certificate No: 1750654S Thursday, 06 June 2024 Infrastructure

Drainet address		Assessor details and therm	al leade	
Project address	Proposed Granny-577	Assessor details and them Assessor number	20348	
Project name Street address	81 BATT Street SEFTON 2182	Assessor number  Certificate number	20348 HR-RO3X59-02	
Local Government Area	Canterbury-Bankstown Council	Climate zone	56	
Plan type and plan number	Deposited Plan DP14988	Area adjusted cooling load (MJ/ m².year)	14	
Lot no.	15	Area adjusted heating load (MJ/	15	
Section no.	-	m².year)		
Project type		Project score		
Project type	dwelling house (detached) - secondary dwelling	Water	<b>✓</b> 40	Target 40
No. of bedrooms	1		V 10	Taliget 40
Site details		Thermal Performance	✓ Pass	Target Pass
Site area (m³)	575	Energy	.4 ==	
Roof area (m²)	110	chergy	<b>√</b> 78	Target 68
Conditioned floor area (m²)	51.1	Materials	✓ 18	Target n/a
Unconditioned floor area (m²)	7.7		,	
Total area of garden and lawn (m²)	120			
Roof area of the existing dwelling (m²)	122			
Number of bedrooms in the existing dwelling	3			

he commitments set out below regulate how the proposed development is to be carried out. It is a condition of any develop evelopment certificate issued, for the proposed development, that BASIX commitments be compiled with.	ment conser	nt granted, or complyi	ng
Water Commitments	Show on DA plans	Show on CC/CDC plans & specs	Certificheck
Landscape			
The applicant must plant indigenous or low water use species of vegetation throughout 50 square metres of the site.	-	~	
Fixtures			
The applicant must install showerheads with a minimum rating of 4 star (> 4.5 but <= 8 L/min plus spray force and/or coverage tests) in all showers in the development.		~	~
The applicant must install a toilet flushing system with a minimum rating of 4 star in each toilet in the development.		~	~
The applicant must install taps with a minimum rating of 5 star in the kitchen in the development.		~	
The applicant must install basin taps with a minimum rating of 5 star in each bathroom in the development.		<b>*</b>	
Alternative water			
Rainwater tank			
The applicant must install a rainwater tank of at least 2500 litres on the site. This rainwater tank must meet, and be installed in accordance with, the requirements of all applicable regulatory authorities.	~	~	~
The applicant must configure the rainwater tank to collect rain runoff from at least 110 square metres of the roof area of the development (excluding the area of the roof which drains to any stormwater tank or private dam).		¥	~
The applicant must connect the rainwater tank to:			
all toilets in the development		-	•
the cold water tap that supplies each clothes washer in the development		<b>,</b>	\

ater Commitments	Show on DA plans	Show on CC/CDC plans & specs	Certifier check
at least one outdoor tap in the development (Note: NSW Health does not recommend that rainwater be used for human consumption in areas with potable water supply.)		~	~
a tap that is located within 10 metres of the swimming pool in the development		•	-
wimming Pool			
e swimming pool must not have a volume greater than 34 kilolitres.	~	~	
e swimming pool must have a pool cover.		~	
e swimming pool must be outdoors.	~	~	

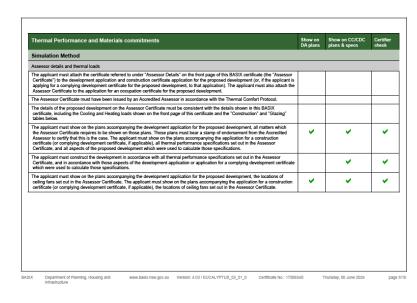

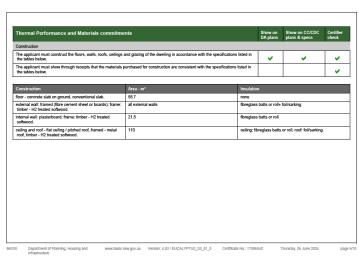


hermal Performance and Materials commitments			Show on DA plans	Show on CC/CDC plans & specs	Certifier check
lazing					
he applicant must install windows, glazed doors and skyl sted in the table.	ights as described in the table belo	w, in accordance with the specifications	~	~	~
rames		Maximum area - m2			
luminium		31.5			
mber		0			
PVC		0			
teel		0			
omposite		0			
lazing		Maximum area - m2			
ingle		0			
ouble		31.5			
iple		0			


Energy Commitments	Show on DA plans	Show on CC/CDC plans & specs	Certifier check
Hot water			
The applicant must install the following hot water system in the development, or a system with a higher energy rating: gas instantaneous with a performance of 5 stars.	~	~	~
Cooling system			
The living areas must not incorporate any cooling system, or any ducting which is designed to accommodate a cooling system.		~	~
The bedrooms must not incorporate any cooling system, or any ducting which is designed to accommodate a cooling system.		~	~
Heating system			
The living areas must not incorporate any heating system, or any ducting which is designed to accommodate a heating system.		~	~
The bedrooms must not incorporate any heating system, or any ducting which is designed to accommodate a heating system.		~	~
Ventilation			
The applicant must install the following exhaust systems in the development:			
At least 1 Bathroom: individual fan, ducted to façade or roof; Operation control: manual switch on/off		-	-
Kitchen: individual fan, ducted to façade or roof; Operation control: manual switch on/off		_	-
Laundry: individual fan, ducted to façade or roof; Operation control: manual switch on/off		<b>~</b>	~
Artificial lighting			
The applicant must ensure that a minimum of 80% of light fixtures are fitted with fluorescent, compact fluorescent, or light-emitting- diode (LED) lamps.		~	~
Natural lighting			
The applicant must install a window and/or skylight in the kitchen of the dwelling for natural lighting.			T


Energy Commitments	Show on DA plans	Show on CC/CDC plans & specs	Certifier check
The applicant must install a window and/or skylight in 1 bathroom(s)/toilet(s) in the development for natural lighting.	¥	¥	~
Swimming pool			
The development must not incorporate any heating system for the swimming pool.		~	
The applicant must install the following pump for the swimming pool in the development, or a pump with a higher energy rating: single speed.		~	
The applicant must install a timer for the swimming pool pump in the development.		~	
Alternative energy			
The applicant must install a photovoltaic system as part of the development. The applicant must connect this system to the development's electrical system.	~	~	~
The photovolatic system must consist of:			
<ul> <li>photovolatic collectors with the capacity to generate at least 2 peak kilowatts of electricity, installed at an angle between 10 degrees and 25 degrees to the horizontal facing north</li> </ul>	~	~	<b>Y</b>
Other			
The applicant must install a gas cooktop & electric oven in the kitchen of the dwelling.		~	
The applicant must install a fixed outdoor clothes drying line as part of the development.		~	

nd					
	erson carning out the de-	velonment			
itments identified with a 💙 in the "Show opment application is to be lodged for the	on DA plans" column mu proposed development).	st be shown on the plans accompanying	the development application for	the proposed development (if a	
itments identified with a 🛩 in the "Show cate / complying development certificate f	on CC/CDC plans and sp or the proposed develop	necs" column must be shown in the plans ment.	and specifications accompany	ing the application for a construc	tion
itments identified with a 🛩 in the "Certifi for the development may be issued.	er check" column must be	e certified by a certifying authority as havi	ing been fulfilled, before a final	occupation certificate (either inte	erim or
	itments identified with a $\checkmark$ in the "Show opment application is to be lodged for the itments identified with a $\checkmark$ in the "Show bate / complying development certificate of itments identified with a $\checkmark$ in the "Certifi	itments identified with a $\checkmark$ in the "Show on DA plans" column mu prement application is to be lodged for the proposed development). Itments identified with a $\checkmark$ in the "Show on CC/CDC plans and sy late / complying development certificate for the proposed development itments identified with a $\checkmark$ in the "Certifier check" column must be	pyment application is to be lodged for the proposed development),  timents identified with a   if he "Show on CC/ICO plans and specs" column must be shown in the plans ate! / complying development certificate for the proposed development.  timents identified with a   if he "Certifier check" column must be certified by a certifying authority as have  timents identified with a   if he "Certifier check" column must be certified by a certifying authority as have	Iments identified with a ♥ in the "Show on DA plans" column must be shown on the plans accompanying the development application for proment application is to be lodged for the proposed development). Imments identified with a ♥ in the "Show on CC/CICC plans and specs" column must be shown in the plans and specifications accompanying development certificate for the proposed development. Imments identified with a ♥ in the "Certifier check" column must be certified by a certifying authority as having been fulfilled, before a final Imments identified with a ♥ in the "Certifier check" column must be certified by a certifying authority as having been fulfilled, before a final Imments identified with a ♥ in the "Certifier check" column must be certified by a certifying authority as having been fulfilled, before a final interest.	Imments identified with a $\checkmark$ in the "Show on DA plans" column must be shown on the plans accompanying the development application for the proposed development (if a application is to be lodged for the proposed development).  Imments identified with a $\checkmark$ in the "Show on CCICOD plans and specs" column must be shown in the plans and specifications accompanying the application for a construction of a construction of the proposed development certificate for the proposed development.  Imments identified with a $\checkmark$ in the "Certifier check" column must be certified by a certifying authority as having been fulfilled, before a final occupation certificate (either intents identified with a $\checkmark$ in the "Certifier check" column must be certified by a certifying authority as having been fulfilled, before a final occupation certificate (either intents identified with a $\checkmark$ in the "Certifier check" column must be certified by a certifying authority as having been fulfilled, before a final occupation certificate (either intents).

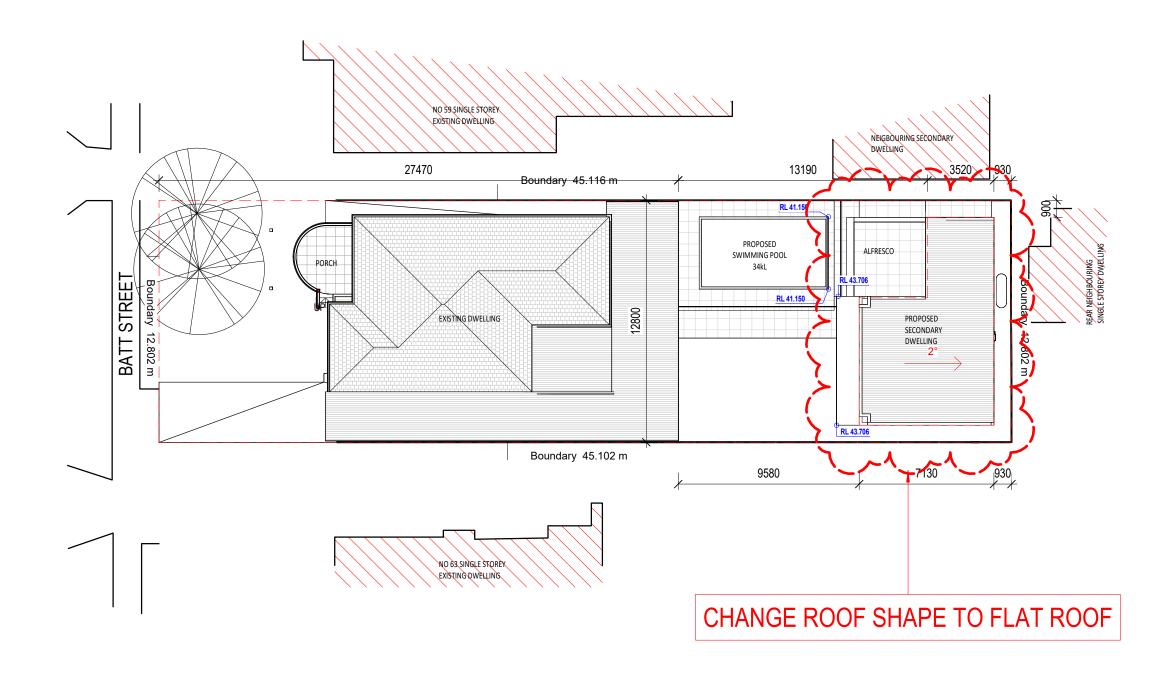




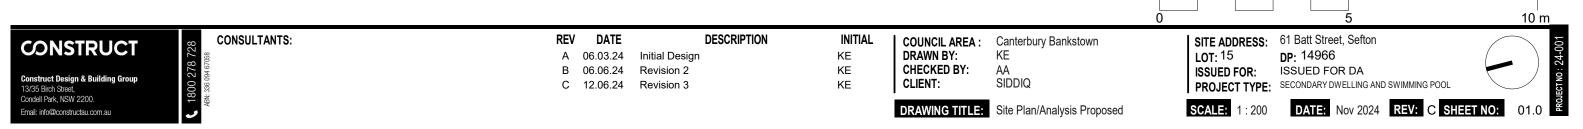


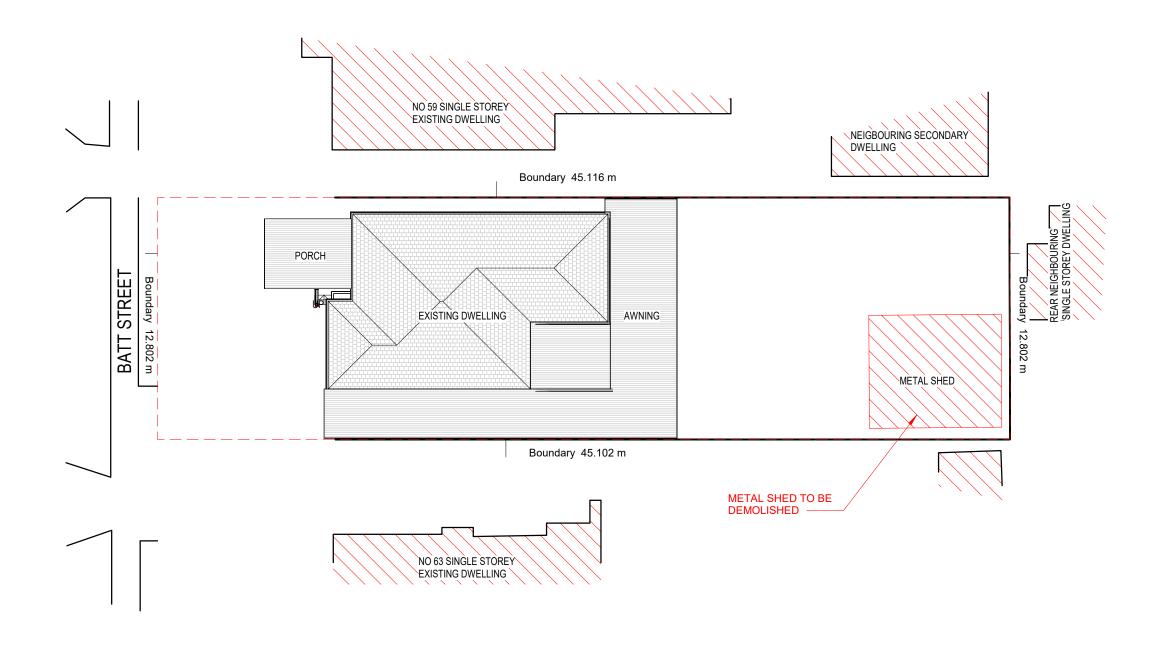




10 m SITE ADDRESS: 61 Batt Street, Sefton
DP: 14966
ISSUED FOR: ISSUED FOR DA COUNCIL AREA: Canterbury Bankstown KE CONSULTANTS: REV DATE **DESCRIPTION** INITIAL **CONSTRUCT** KE KE 06.03.24 Initial Design AA SIDDIQ B 06.06.24 Revision 2 **CHECKED BY: Construct Design & Building Group** 13/35 Birch Street, Condell Park, NSW 2200. PROJECT TYPE: SECONDARY DWELLING AND SWIMMING POOL ΚE CLIENT: C 12.06.24 Revision 3 **DATE:** Nov 2024 **REV:** C **SHEET NO:** 01.1 **DRAWING TITLE:** Demolition Plan Email: info@constructau.com.au

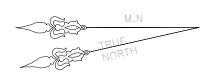


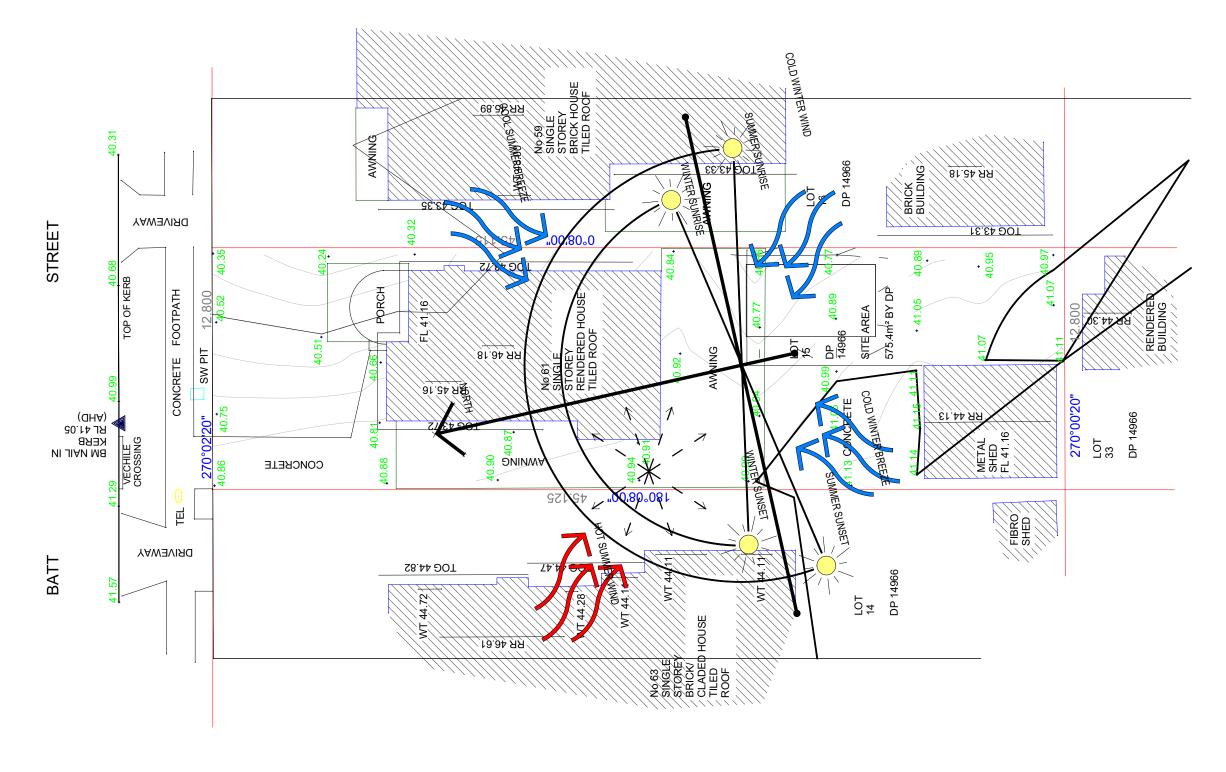





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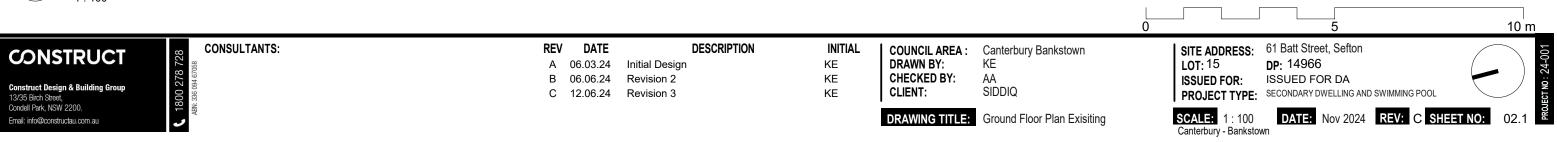


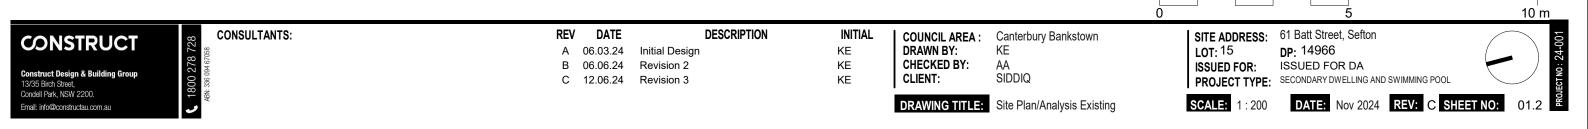

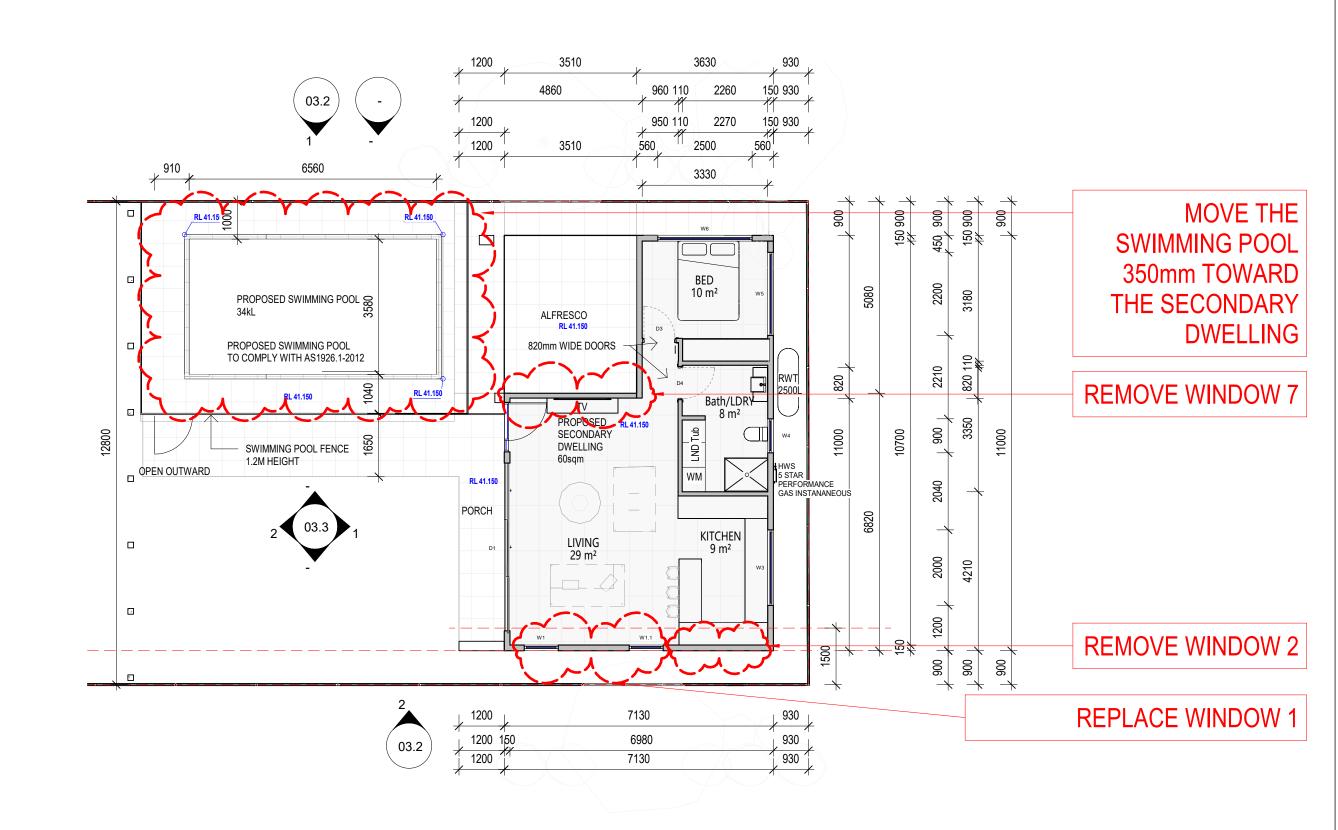



## Ground Floor Plan Existing

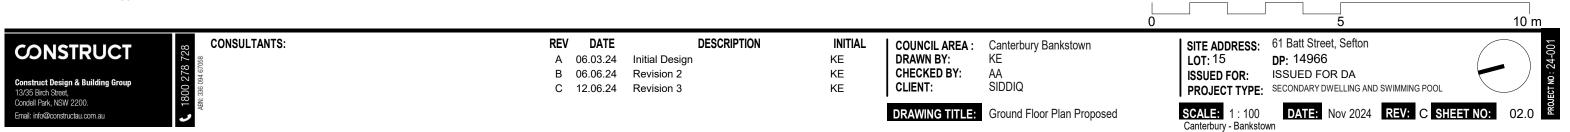
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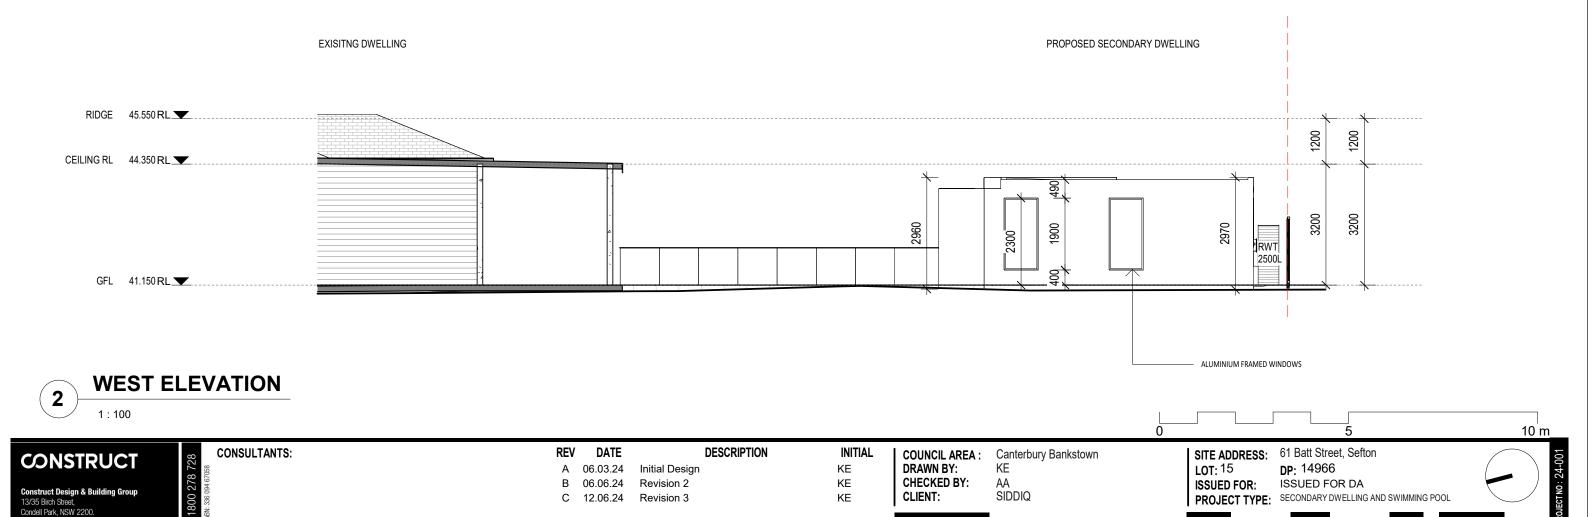


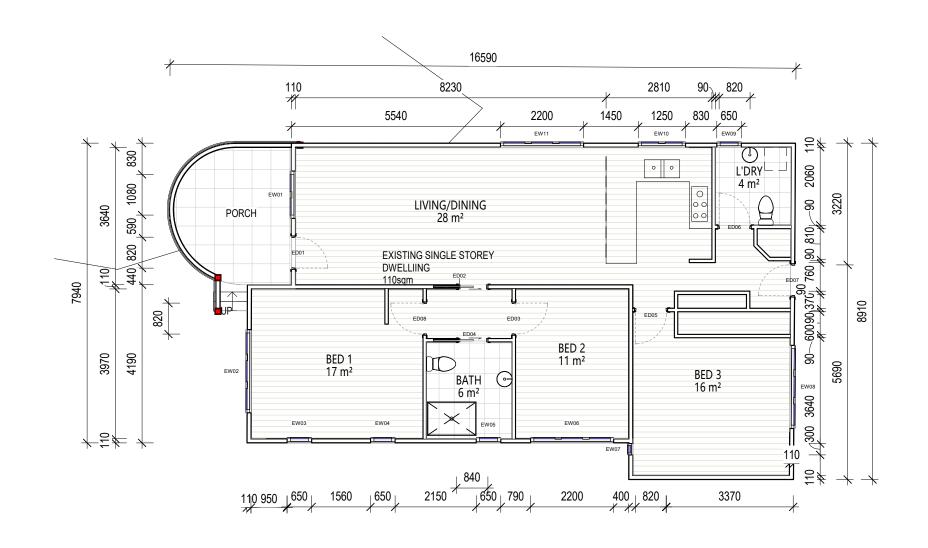



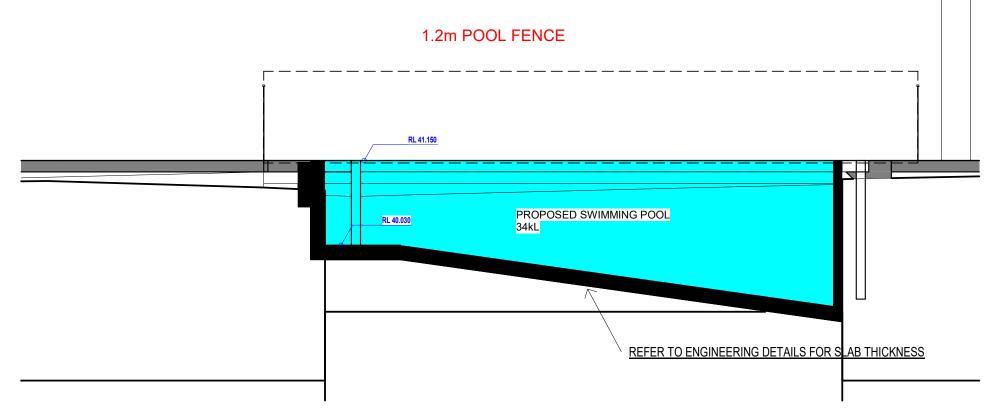

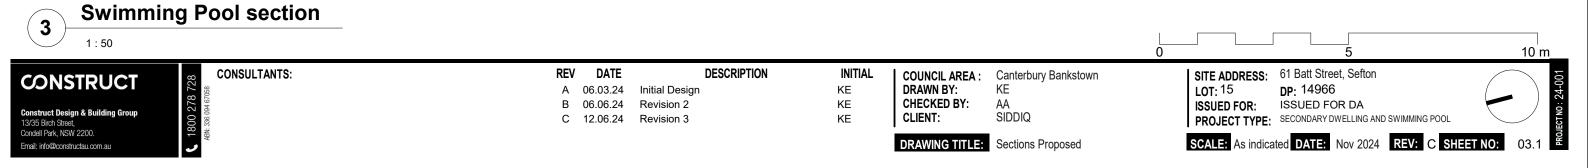
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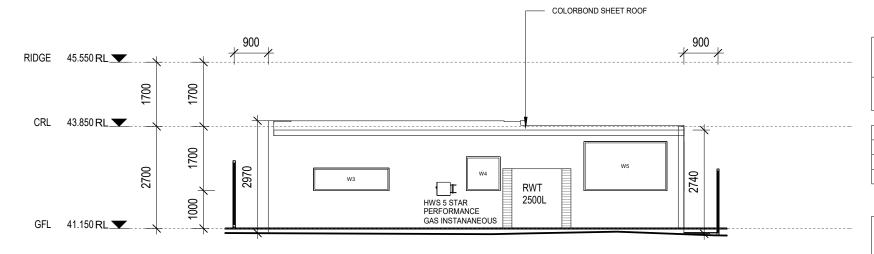
**DRAWING TITLE:** Elevations

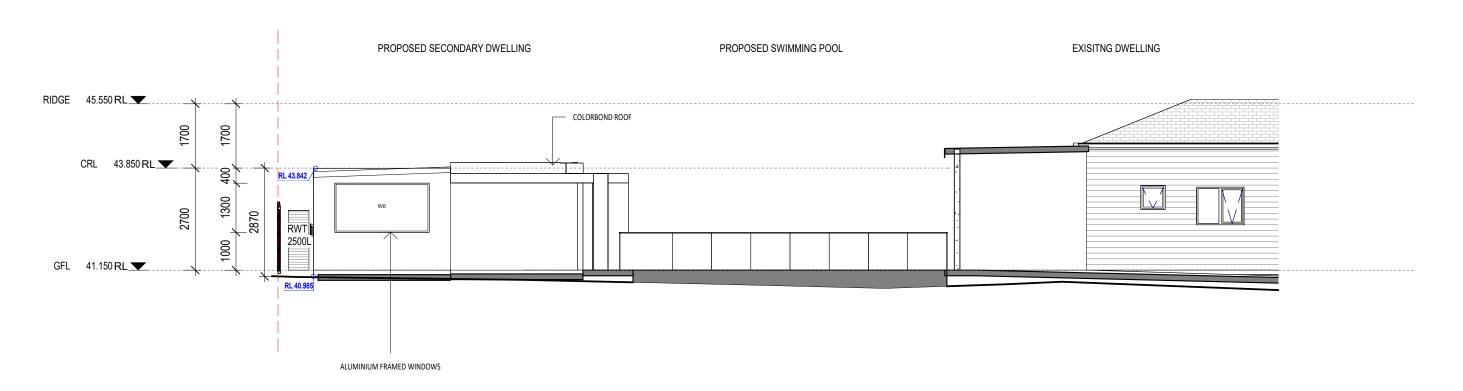DATE: Nov 2024 REV: C SHEET NO:



### **North Elevation**

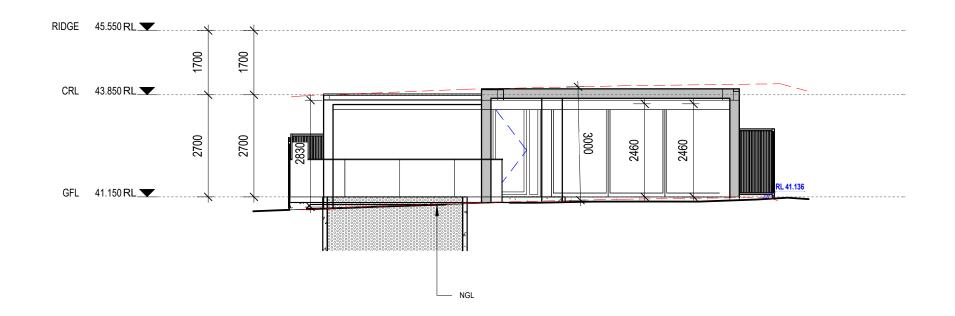1:100



		Door S	chedule				
Mark	Location	Frame Type	Height	Width	Finish	Frame Material	
D1	GFL		2460	4500			
D2	GFL		2460	1310			
D3	GFL		2100	820			
D4	GFL		2100	820			
Grand total: 4							

Window Schedule						
Mark	Location	Window Style	Height	Width	Material	Glazing
W1			1900	900		
W1.1			1900	900		
W3	KITCHEN	SLIDING	600	2000	ALUMINIUM	
W4	BATHROOM	SLIDING	900	900	ALUMINIUM	
W5	BEDROOM	SLIDING	1300	2200	ALUMINIUM	
W6	BEDROOM	SLIDING	1300	2500	ALUMINIUM	

**South Elevation** 

1:100

CONSTRUCT
Construct Design & Building Group 13/35 Birch Street, Condell Park, NSW 2200.
Email: info@constructau.com.au

CONSULTANTS:

REV DATE A 06.03.24 Initial Design B 06.06.24 Revision 2 C 12.06.24 Revision 3

**DESCRIPTION** 

INITIAL ΚE ΚE ΚE **DRAWING TITLE:** Elevations Proposed

CHECKED BY: CLIENT:

COUNCIL AREA: Canterbury Bankstown KE AA SIDDIQ


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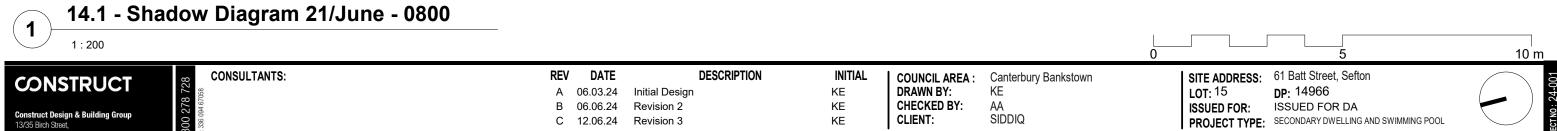
SITE ADDRESS: 61 Batt Street, Sefton DP: 14966 ISSUED FOR DA

PROJECT TYPE: SECONDARY DWELLING AND SWIMMING POOL

DATE: Nov 2024 REV: C SHEET NO:

10 m




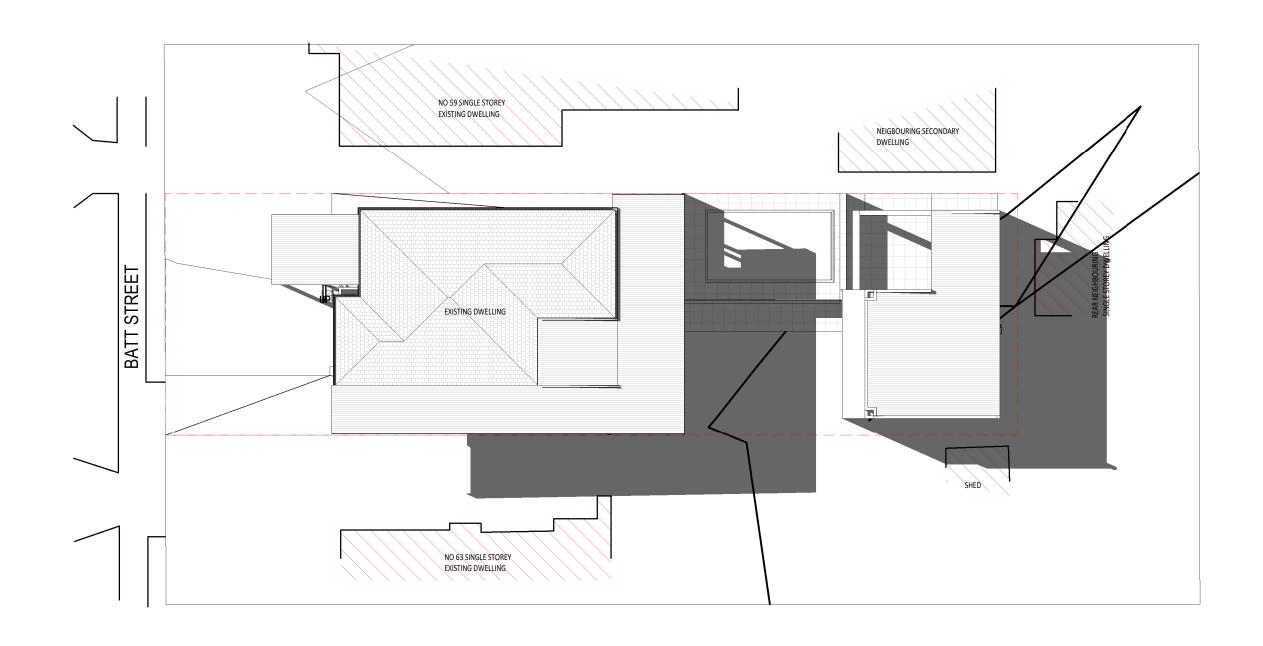

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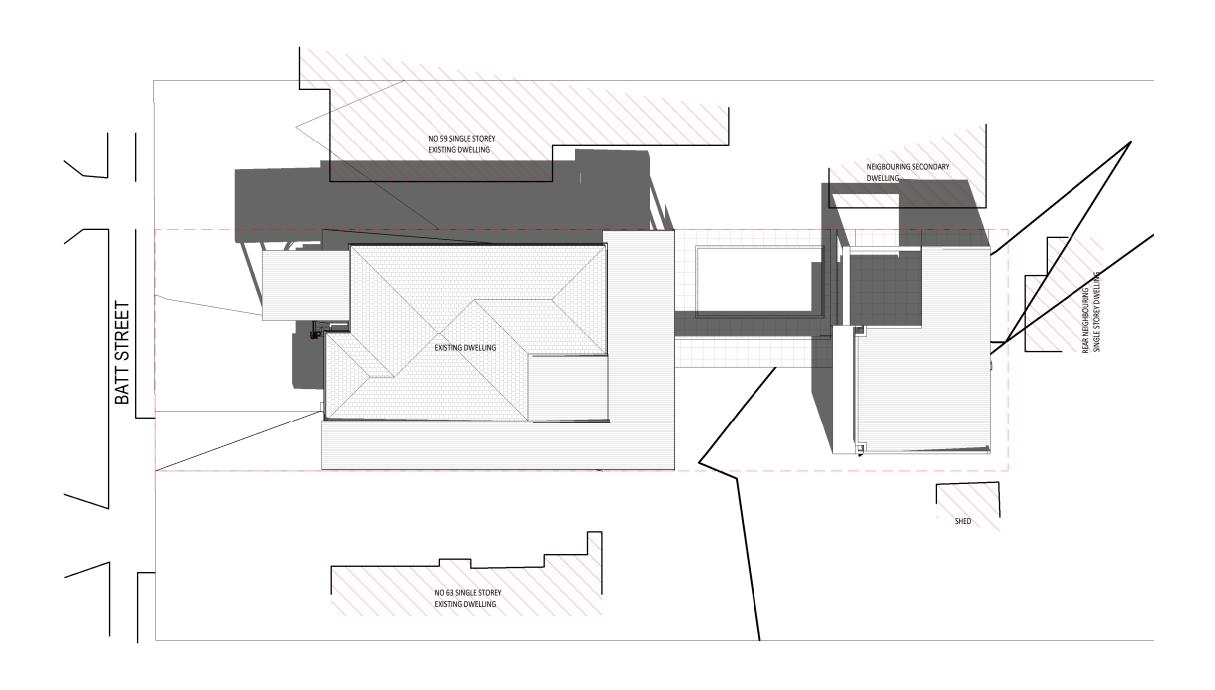
AA SIDDIQ **DRAWING TITLE:** Shadow Diagrams - June

DATE: Nov 2024 REV: C SHEET NO:

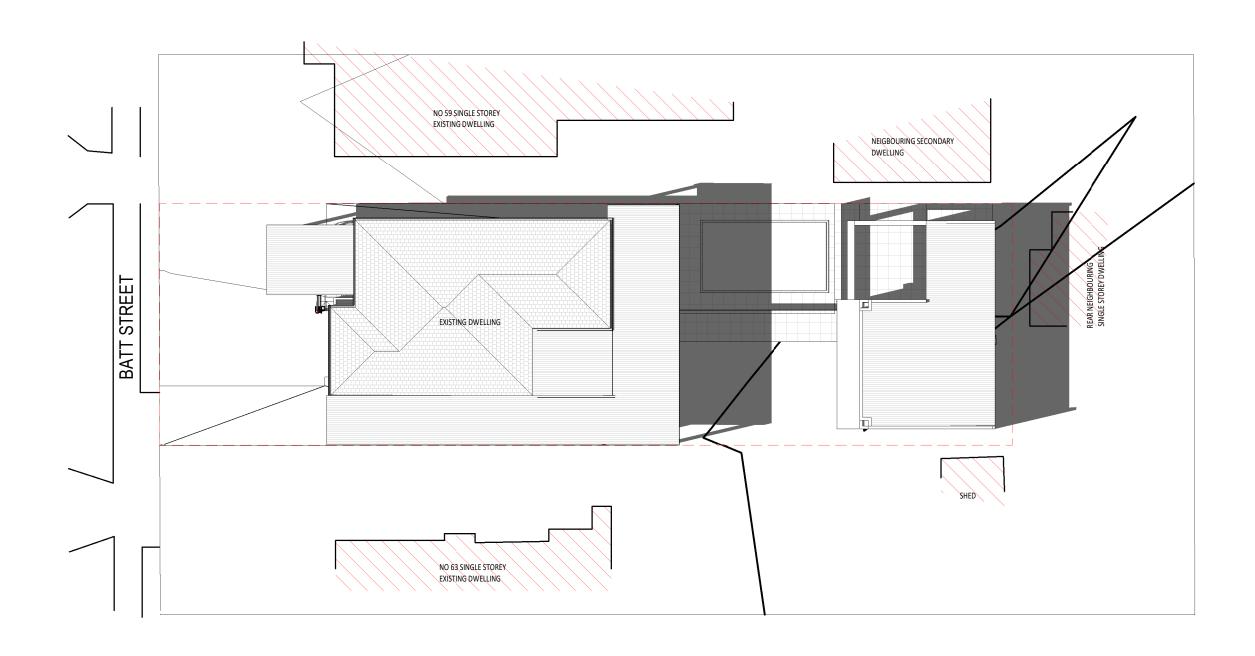


# 14.2 - Shadow Diagram 22/June - 1200


10 m SITE ADDRESS: 61 Batt Street, Sefton
LOT: 15 DP: 14966
ISSUED FOR: ISSUED FOR DA COUNCIL AREA: Canterbury Bankstown DRAWN BY: KE CONSULTANTS: REV DATE **DESCRIPTION** INITIAL **CONSTRUCT** KE KE A 06.03.24 Initial Design AA SIDDIQ B 06.06.24 Revision 2 CHECKED BY: Construct Design & Building Group 13/35 Birch Street, Condell Park, NSW 2200. PROJECT TYPE: SECONDARY DWELLING AND SWIMMING POOL ΚE CLIENT: C 12.06.24 Revision 3 DATE: Nov 2024 REV: C SHEET NO: **DRAWING TITLE:** Shadow Diagrams - June Email: info@constructau.com.au




## 14.3 - Shadow Diagram 23/June - 1600

**(1**) 10 m SITE ADDRESS: 61 Batt Street, Sefton
LOT: 15 DP: 14966
ISSUED FOR: ISSUED FOR DA COUNCIL AREA: Canterbury Bankstown DRAWN BY: KE CONSULTANTS: REV DATE **DESCRIPTION** INITIAL **CONSTRUCT** KE KE A 06.03.24 Initial Design AA SIDDIQ B 06.06.24 Revision 2 **CHECKED BY:** Construct Design & Building Group 13/35 Birch Street, Condell Park, NSW 2200. PROJECT TYPE: SECONDARY DWELLING AND SWIMMING POOL ΚE CLIENT: C 12.06.24 Revision 3 **DATE:** Nov 2024 **REV:** C **SHEET NO: DRAWING TITLE:** Shadow Diagrams - June Email: info@constructau.com.au

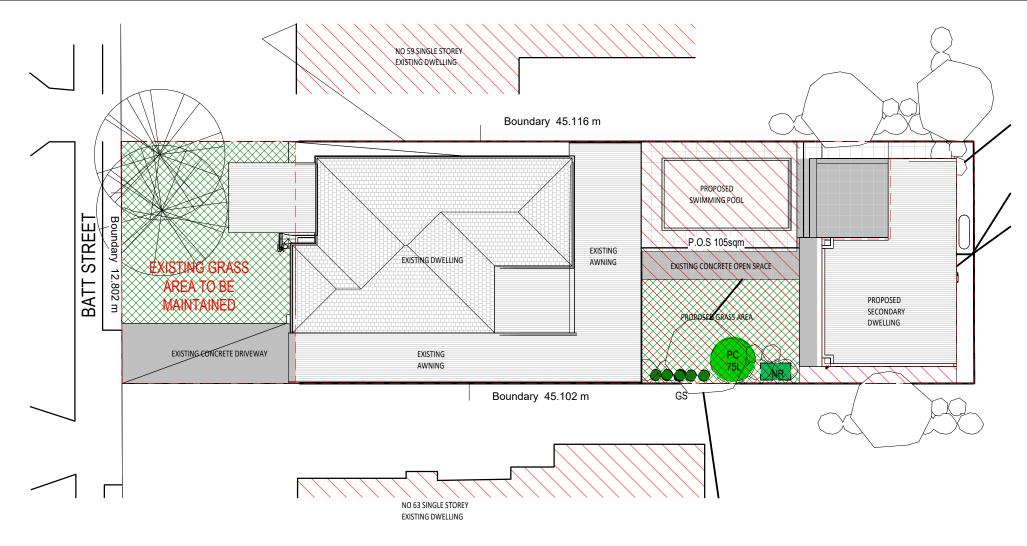

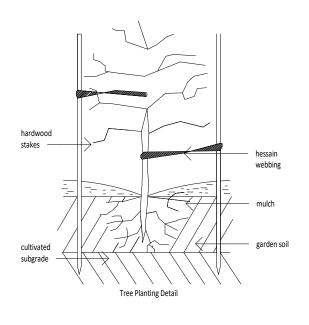

#### Selected non-extruded brick laid in mortar bed

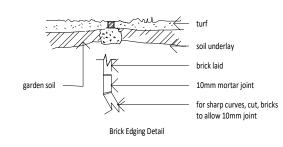


### 15 - Concept Landscape Plan

### LOW WATER USE SPECIES OF VEGETAION WITH A TOTAL OF 50sqm ARE PLANTED THOUGHOUT THE SITE.

Landscaping Notes:						Legend
	PC - Pyrus Calleryana	Callery Pear	1	Yes	75L	PC
General Notes  * Prior to the commencent of any site works, all existing trees to be retained shall be enclosedwith protective fencing to prevent them being damaged during the construction period.  * All finished levels are to be verified by the builder on site.	Shrubs Gs - Grevillea Sericea	Pink Spider Flower	31	-	5L	GS
* All landscaping work to be in strict accordance to councils/privated certifiers code and guidlines.  *This drawing is to be read in conjuction with all submitted architectural.  * Hydraulics and engineering drawings where applicable.	Nr - Native Rosemary Aussie Box	Westringia hybrida Aussie Box	Planter	-	10L	NR

575.4sqm		
60sqm		
74sqm		
24sqm		
45qm		
119sqm		
20%		
105sqm		



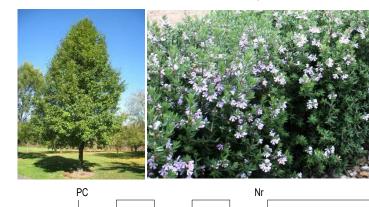

**CONSTRUCT** Construct Design & Building Group Condell Park, NSW 2200.

CONSULTANTS:

REV

06.03.24 Initial Design B 06.06.24 Revision 2 C 12.06.24 Revision 3

INITIAL ΚE ΚE ΚE

COUNCIL AREA: Canterbury Bankstown KE **CHECKED BY:** CLIENT:

AA SIDDIQ

ISSUED FOR: PROJECT TYPE: SECONDARY DWELLING AND SWIMMING POOL

SITE ADDRESS: 61 Batt Street, Sefton DP: 14966 ISSUED FOR DA

10 m

DRAWING TITLE: Concept Landscap Plan

SCALE: As indicated DATE: Nov 2024 REV: C SHEET NO: 05.0

Email: info@constructau.com.au

DATE

**DESCRIPTION** 

